

## **GENERAL SITE NOTES:**

- CONTRACTOR WILL NOT START CONSTRUCTION UNTIL AFTER THEY HAVE RECEIVED THE PRE-CON PACKAGE AND HAVE A PRE-CON WALK WITH THE PROJECT MANAGER.
- CONTRACTOR TO HIRE PUBLIC (811) AND PRIVATE LOCATING SERVICE IN ORDER TO LOCATE AND PROTECT ALL SURFACE UTILITIES. DO NOT SCALE OFF THESE PLANS FOR ANY BELOW GRADE LITH LITTES.
- 3. CONTRACTOR SHALL VERIFY ALL EXISTING BURIED AND OVERHEAD UTILITIES PRIOR TO EXCAVATION. CONTRACTOR SHALL REPAIR ALL DAMAGED UTILITIES AT HIS OWN COST AND COORDINATE ANY REPAIRS WITH RESPECTIVE UTILITY COMPANY.
- CONTRACTOR TO VERIFY ALL HEIGHTS AND AZIMUTHS IN FIELD PRIOR TO CONSTRUCTION. CONTRACTOR SHALL NOTIFY T-MOBILE AND ENGINEERING FIRM OF ANY DISCREPANCIES BEFORE PROCEEDING.
- 5. CONTRACTOR SHALL RESTORE AND REPAIR ANY DAMAGED AREAS CAUSED BY CONSTRUCTION.

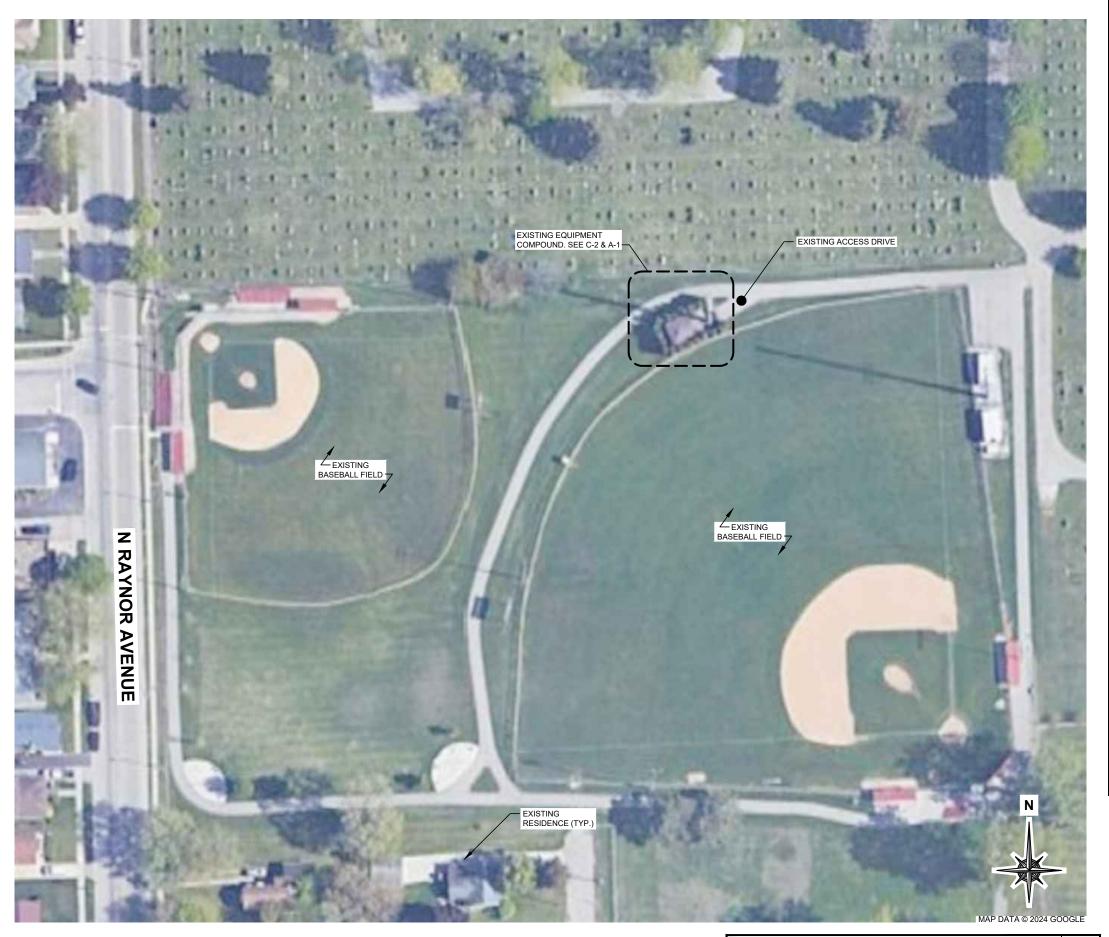

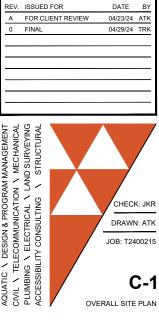

ENGINEER OF

REVISIONS

1


WT GROUP Engineering with Predsion, Pace an 2675 Patum Awnue Hoffman Esta T. 224.298.6339 | F. 224.298.6444 wingsheering.com

GARNSEY PARK RL CH75294D

Mobile:

**OVERALL SITE PLAN** 

SCALE: 1" = 70'-0"

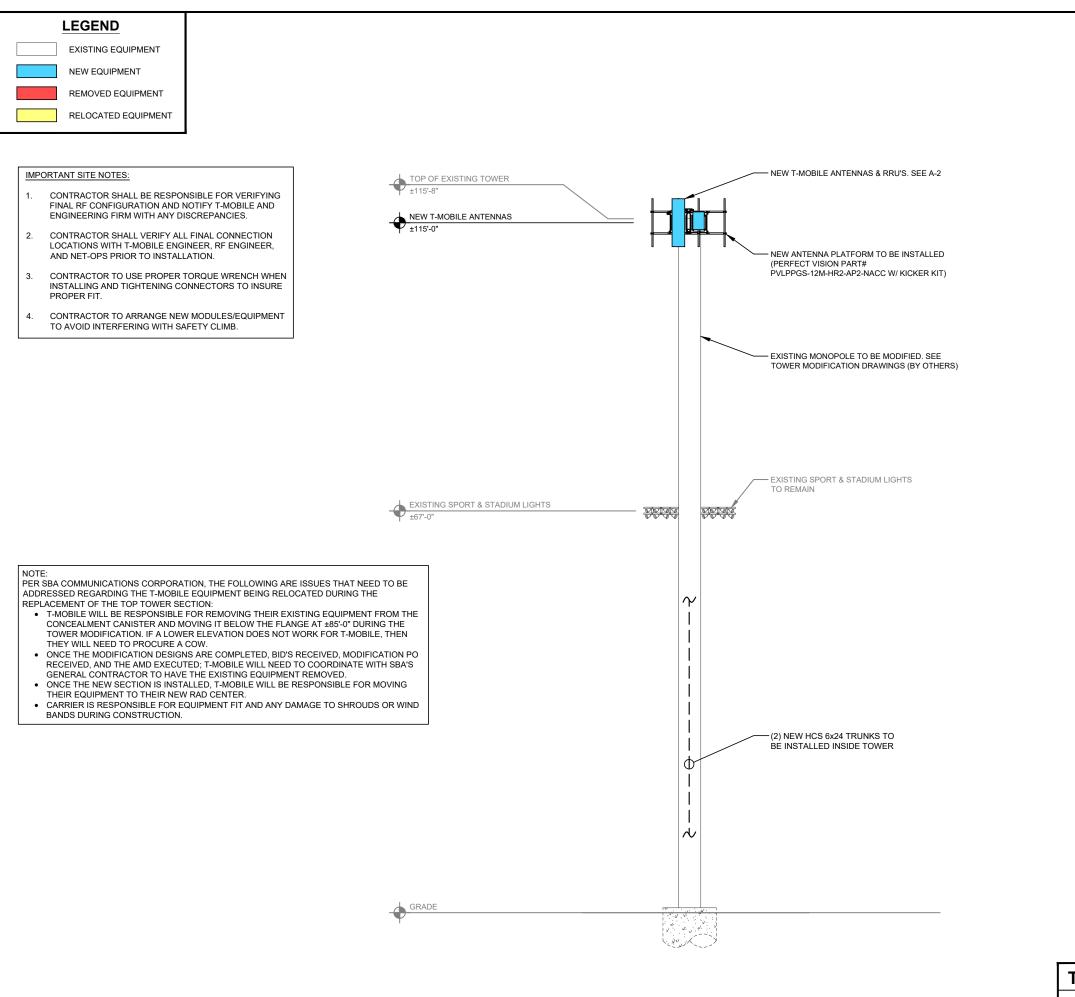

A FAILING STRUCTURAL ANALYSIS OF THE EXISTING TOWER HAS BEEN COMPLETED BY TOWER ENGINEERING SOLUTIONS ON MARCH 12, 2024. CONTRACTOR TO VERIFY EXISTING TOWER IS MODIFIED PRIOR TO CONSTRUCTION. PER THE STRUCTURAL ANALYSIS IT IS RECOMMENDED TO REPLACE EXISTING CANISTER WITH 16" X 0.375" X 19'-4" NEW POLE SECTION FROM 95'-8" TO 115'-0" AND REINFORCE THE FLANGE CONNECTION AT 35.25'. THE REINFORCED TOWER SHALL BE ANALYZED PRIOR TO THE INSTALLATION OF THIS DESIGN.

WT'S SCOPE OF WORK DOES NOT INCLUDE A STRUCTURAL ANALYSIS OF THIS ANTENNA MOUNT. NEW ANTENNAS AND EQUIPMENT SHOWN ON THIS PLAN HAVE NOT BEEN EVALUATED TO VERIFY THE MOUNT HAS THE CAPACITY TO ADEQUATELY SUPPORT THESE ANTENNAS. PRIOR TO ANY ANTENNA OR EQUIPMENT INSTALLATION, A STRUCTURAL EVALUATION OF THE MOUNT, INCLUDING ALL ANTENNA MOUNTING SYSTEMS & HARDWARE SHALL BE PERFORMED.

ANTENNA CENTERLINE'S VERTICAL OFFSET FROM PLATFORM DECK OR HORIZONTAL CENTER OF SECTOR FRAME SHALL NOT EXCEED 6".

Mobile

WT GROUP

Engineering with Predision, Pace an

GARNSEY PARK RL CH75294D

PROFESSIONAL

ENGINEER OF

EXPIRES: 11/30/25

**REVISIONS** 

m


REV. ISSUED FOR A FOR CLIENT REVIEW 04/23/24 ATM 04/29/24 TRI

1

CHECK: JKR DRAWN: ATK JOB: T2400215 TOWER ELEVATION

**TOWER ELEVATION** 

SCALE: 1/16" = 1'-0"

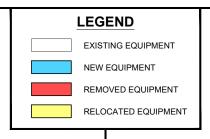

NEW 840590966 ANTENNA

GAMMA = 240°

NEW ANTENNA PLATFORM TO BE INSTALLED

PVLPPGS-12M-HR2-AP2-NACC W/ KICKER KIT)

NEW AEHC ANTENNA TO BE INSTALLED -

(PERFECT VISION PART#

TO BE INSTALLED-

A FAILING STRUCTURAL ANALYSIS OF THE EXISTING TOWER HAS BEEN COMPLETED BY TOWER ENGINEERING SOLUTIONS ON MARCH 12, 2024. CONTRACTOR TO VERIFY EXISTING TOWER IS MODIFIED PRIOR TO CONSTRUCTION. PER THE STRUCTURAL ANALYSIS IT IS RECOMMENDED TO REPLACE EXISTING CANISTER WITH 16" X 0.375" X 19'-4" NEW POLE SECTION FROM 95'-8" TO 115'-0" AND REINFORCE THE FLANGE CONNECTION AT 35.25'. THE REINFORCED TOWER SHALL BE ANALYZED PRIOR TO THE INSTALLATION OF THIS DESIGN.

WT'S SCOPE OF WORK DOES NOT INCLUDE A STRUCTURAL ANALYSIS OF THIS ANTENNA MOUNT. NEW ANTENNAS AND EQUIPMENT SHOWN ON THIS PLAN HAVE NOT BEEN EVALUATED TO VERIFY THE MOUNT HAS THE CAPACITY TO ADEQUATELY SUPPORT THESE ANTENNAS. PRIOR TO ANY ANTENNA OR EQUIPMENT INSTALLATION, A STRUCTURAL EVALUATION OF THE MOUNT, INCLUDING ALL ANTENNA MOUNTING SYSTEMS & HARDWARE SHALL BE PERFORMED.

ANTENNA INFORMATION OBTAINED FROM T-MOBILE RF DATA CONFIGURATION SHEET DATED 02/06/24.

- NEW AHFIG TO BE INSTALLED

NEW AEHC ANTENNA TO BE

(TYP. OF 1 PER SECTOR)

INSTALLED


BETA = 120°

NEW 840590966 ANTENNA TO BE

INSTALLED

# ALPHA = 0° EXISTING ANTENNA TO BE REMOVED (TYP. OF 3, 1 PER SECTOR) EXISTING STEALTH CANISTER TO BE REMOVED -- EXISTING TMA TO BE REMOVED (TYP. OF 6, 2 PER SECTOR) (CONTRACTOR TO VERIFY INSTALLATION IN FIELD) BETA = 120° GAMMA = 240°

## 111'-6" ELEVATION

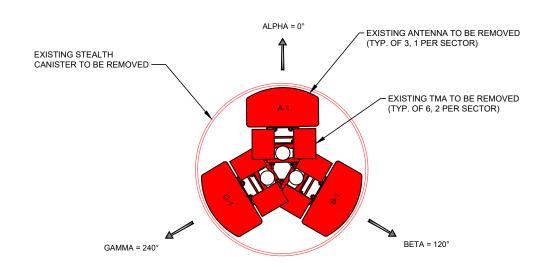

### 104'-0" ELEVATION



1

**EXISTING ANTENNA PLANS** 

SCALE: NONE

- EXISTING MODIFIED MONOPOLE. SEE TOWER MODIFICATION DRAWINGS (BY OTHERS)

**NEW ANTENNA PLAN** 

SCALE: NONE

2

m

Mobile

GARNSEY PARK RL CH75294D

WT GROUP

Engineering with Predision, Pace an



EXPIRES: 11/30/25

**REVISIONS** REV. ISSUED FOR A FOR CLIENT REVIEW 04/23/24 ATM 04/29/24 TRH



JOB: T2400215

**A-2** ANTENNA PLANS

CHECK: JKR DRAWN: ATK

